# Happy Hollow Park Ravine Footpath Repair

November 15, 2012

#### **OWNER:**

#### City of West Lafayette, Indiana

Department of Parks and Recreation 609 West Navajo Street West Lafayette, Indiana 47906 (765) 775.5110

#### CONSULTANTS:

Parsons Brinckerhoff (Design) 300 North Meridian Street, Suite 1010 Indianapolis, Indiana 46204 t. (317) 972.1706 f. (317) 972.1708

TBIRD Design Services Corp. (Surveying)
105 North 10th Street
Lafayette, Indiana 47901
t. (765) 742-1900 f. (765) 742.1905

#### INDEX OF SHEETS

COVER SHEET	
NOTES, LEGEND AND SCHEDULES	C0.1
CONSTRUCTION STAGING PLAN	C0.2
PLAN AND PROFILE - ALIGNMENT 1	C1.1
PLAN AND PROFILE - ALIGNMENT 2	C1.2
BOARDWALK DETAILS	C2.1
BRIDGE DETAILS	C2.2

#### PROJECT INFORMATION


#### PROJECT LENGTH

ALIGNMENT 1: STATIONS 10+00 TO 14+94.15 (495.15 FEET) ALIGNMENT 2: STATIONS 10+00 TO 15+59.27 (559.27 FEET)

#### PROJECT LIMITS

PARK ACCESS POINT AT THE NORTHEAST SIDE OF NORTH SALISBURY STREET BETWEEN CARROLTON BLVD AND NORTH GRANT STREET. BEGINNING AT THE BOTTOM OF THE EXISTING BOARDWALK STAIRS TO THE INTERSECTION WITH THE EXISTING HAPPY HOLLOW PARK TRAIL.

#### VICINITY MAP - WEST LAFAYETTE, IN

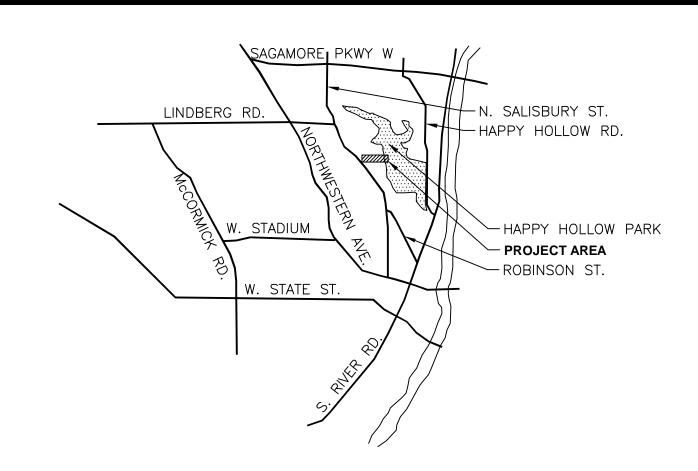

#### CONTROL POINT TABLE


POINT #	NORTHING	EASTING	ELEV	DESCRIPTION
1	1891720.21	3000761.42	714.13	MAG NAIL W/TBIRD TRAV. PT. WASHER SET
2	1891103.36	3001322.80	720.07	MAG NAIL W/TBIRD TRAV. PT. WASHER SET
3	1891386.27	3002530.75	576.17	1/2" REBAR W/TBIRD TRAV. PT. CAP SET
4	1891004.03	3003015.93	565.06	1/2" REBAR W/TBIRD TRAV. PT. CAP SET
12	1892383.95	3002247.68	595.92	MAG NAIL W/TBIRD TRAV. PT. WASHER SET
13	1892182.41	3002491.46	588.10	MAG NAIL W/TBIRD TRAV. PT. WASHER SET
14	1891771.56	3002609.48	582.69	MAG NAIL W/TBIRD TRAV. PT. WASHER SET
105	1891825.66	3000827.08	689.64	1/2" REBAR W/TBIRD TRAV. PT. CAP SET
106	1891898.44	3000851.12	677.74	1/2" REBAR W/TBIRD TRAV. PT. CAP SET
107	1891947.84	3001037.11	683.13	1/2" REBAR W/TBIRD TRAV. PT. CAP SET
108	1892063.20	3001250.78	665.92	1/2" REBAR W/TBIRD TRAV. PT. CAP SET
109	1892226.48	3001391.29	660.04	1/2" REBAR W/TBIRD TRAV. PT. CAP SET
110	1892358.13	3001659.40	622.57	1/2" REBAR W/TBIRD TRAV. PT. CAP SET
111	1892276.21	3001910.68	610.52	1/2" REBAR W/TBIRD TRAV. PT. CAP SET

#### BENCHMARK TABLE

97	625.46	"X" CUT IN NORTH RIM OF MANHOLE
98	655.23	T POST SET 2.0' ABOVE GRADE, 12' NORTH OF TRAIL CENTERLINE AND 5' SOUTHEAST OF 6' BOULDER
99	682.07	T-POST SET 2.0' ABOVE GRADE 5' SOUTH OF TRAIL CL & 5' EAST OF 15" BASSWOOD
100	715.03	"X" CUT IN NORTHERN BONNET BOLT IN FIRE HYDRANT @ CARROLTON & SALISBURY

NOTE: NOT ALL SURVEYED BENCHMARKS AND CONTROL POINTS LISTED ABOVE ARE SHOWN ON THESE DRAWINGS. COMPLETE SURVEY DRAWINGS ARE AVAILABLE UPON REQUEST FROM THE OWNER.

#### LEGEND

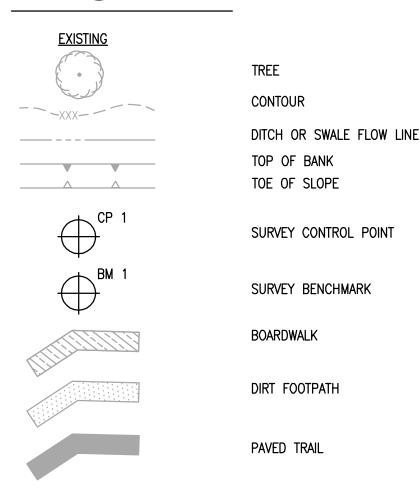

#### **ABBREVIATIONS**

ASTM ALSC ASME AWPA BM CP DOC PS 20	AMERICAN SOCIETY OF TESTING AND MATERIALS AMERICAN LUMBER STANDARD COMMITTEE AMERICAN SOCIETY OF MECHANICAL ENGINEERS AMERICAN WOOD PROTECTION ASSOCIATION BENCHMARK CONTROL POINT AMERICAN SOFTWOOD LUMBER STANDARD PS 20	
E	FAST	
ELEV	FLEVATION	
INDOT	INDIANA DEPARTMENT OF TRANSPORTATION	
LBS	POUNDS	
N	NORTH	
NO.	NUMBER	
PI	POINT OF INTERSECTION	
TBR	TO BE REMOVED	
TYP	TYPICAL	
S	SOUTH	
SF		
W W	SQUARE FOOT (FEET)	
VV	WEST	

#### GENERAL NOTES

- 1. PROTECT ALL TREES TO REMAIN FROM CONSTRUCTION ACTIVITIES. 2. TREES TO BE REMOVED SHALL BE TAGGED FOR APPROVAL BY THE OWNER'S
- REPRESENTATIVE PRIOR TO REMOVAL BY THE CONTRACTOR.
- 3. ALL EXCAVATED SOIL SHALL BE PROPERLY DISPOSED OF ON-SITE IN A MANNER THAT WILL NOT ALLOW RUN OFF OF SEDIMENTS INTO DITCHES OR CREEKS. DEPOSIT EXCAVATED MATERIAL AT LEAST 50 FEET AWAY FROM ANY DITCH, STREAM OR CHANNEL THAT MAY CONVEY RUNOFF. DO NOT DEPOSIT MATERIAL ON SLOPES STEEPER THAN 4:1. SPREAD EXCAVATED MATERIAL TO A DEPTH OF 2" MAXIMUM, EXCEPT AT DEPRESSION IN THE LANDSCAPE THAT MAY BE FILLED WITHOUT THE POSSIBILITY OF CONVEYANCE. TAMP COMPACT EXCAVATED MATERIAL AND COVER WITH 3" MINIMUM DEPTH LEAVES OR STRAW MULCH TO PROTECT IT FROM EROSION.
- 4. THE CONTRACTOR SHALL SUBMIT ANY REVISIONS TO THE CONSTRUCTION STAGING PLAN FOR APPROVAL BY THE OWNER PRIOR TO BEGINNING CONSTRUCTION ACTIVITIES OR DELIVERING MATERIALS TO THE SITE.
- 5. BOLT HOLES SHALL BE  $\frac{1}{16}$ " MAXIMUM AND  $\frac{1}{32}$ " MINIMUM LARGER THAN BOLT
- UNLESS OTHERWISE INDICATED ALL BOLTS SHALL BE MACHINE BOLTS. 7. ALL EXPOSED BOLTS THAT ARE ORIENTED PERPENDICULAR TO THE BOARDWALK
- OR BRIDGE SHALL HAVE BOLT HEADS FACING THE EXTERIOR. 8. SINK SCREW HEADS FLUSH WITH LUMBER.

#### **SPECIFICATIONS**

- 1. APPLICABLE CODES: INDIANA BUILDING CODE, 2008
- 2. DESIGN LOADS
- 2.1. BOARDWALK, BRIDGE AND STAIRS: 60 PSF LIVE LOAD HANDRAILS AND GUARDS: 200 LBS CONCENTRATED LOAD IN ANY
- DIRECTION AT ANY POINT ALONG THE TOP. RAIL COMPONENTS (EXCEPT HANDRAIL) 50 LBS APPLIED HORIZONTALLY TO A 1 SF AREA.
- CONCRETE:
- PACKAGED: STRUCTURAL CONCRETE MIX, NORMAL SET, 4000 PSI AT 28 DAYS, ASTM C 387.
- MIX IN ACCORDANCE WITH MANUFACTURES WRITTEN INSTRUCTIONS.
- STORE IN A DRY, EASILY ACCESSIBLE, LEVEL LOCATION. READY MIX: INDOT CLASS A STRUCTURAL CONCRETE IN ACCORDANCE
- WITH SECTION 702 OF THE INDOT STANDARD SPECIFICATIONS. FORM FACING MATERIALS: PROVIDE CONTINUOUS, TRUE AND SMOOTH CONCRETE SURFACES. ABOVE GRADE PIER FORMS BY SONOTUBE OR SIMILAR PRODUCT.
- 4. PIPE AND TUBE RAILINGS
- BRACKETS, FLANGES AND ANCHORS SHALL BE CAST OR FORMED METAL OF SAME MATERIAL AND FINISH AS SUPPORTED RAILS.
- PIPE: ASTM A 53, TYPE S, GRADE A, STANDARD WEIGHT (SCHEDULE
- PLATES, SHAPES AND BARS: ASTM A 36
- GALVANIZING REPAIR PAINT: HIGH ZINC-DUST CONTENT PAINT COMPLYING WITH SSPC-PAINT 20. FABRICATION:
- CUT, DRILL AND PUNCH METALS CLEANLY AND ACCURATELY. REMOVE BURRS AND EASE EDGES TO A RADIUS OF APPROXIMATELY 1/32". REMOVE SHARP OR ROUGH AREAS ON EXPOSED SURFACES.
- FORM WORK TRUE TO LINE AND LEVEL WITH ACCURATE ANGLE AND SURFACES.
- COPE COMPONENTS AT CONNECTIONS TO PROVIDE CLOSE FIT. WELD CONNECTIONS ALL AROUND AT CONNECTIONS, INCLUDING AT FITTINGS. USE MATERIALS AND METHODS THAT MINIMIZE DISTORTION AND DEVELOP STRENGTH AND CORROSION RESISTANCE. OBTAIN FUSION WITHOUT UNDERCUT OR OVERLAP. REMOVE FLUX IMMEDIATELY. FINISH EXPOSED SURFACES SMOOTH AND BLENDED SO NO ROUGHNESS SHOWS AFTER FINISHING AND WELD SURFACE SO IT MATCHES CONTOURS OF ADJOINING
- FORM CHANGES IN DIRECTION BY BENDING MEMBERS IN JIGS TO PRODUCE UNIFORM CURVATURE WITH OUT BUCKLING OR DEFORMATIONS OF EXPOSED SURFACE.
- CLOSE EXPOSED ENDS OF RAILING WITH PREFABRICATED END FITTINGS. PROVIDE WALL RETURNS AT ENDS OF WALL-MOUNTED HANDRAILS.
- PROVIDE BRACKETS, FLANGES, FITTINGS AND ANCHORS TO
- INTERCONNECT RAILING MEMBERS TO OTHER WORK. FINISHES: HOT-DIP GALVANIZE RAILINGS, INCLUDING HARDWARE, AFTER FABRICATION.
- 5. METAL FABRICATIONS 5.1. GENERAL: PROVIDE MATERIALS WITH SMOOTH, FLAT SURFACES, WITHOUT SEAM MARKS, ROLLER MARKS, ROLLED TRADE NAMES OR
- FERROUS METALS: STEEL PLATES, SHAPES AND BARS PER ASTM A 36. STEEL TUBING PER ASTM A 500, GRADE B COLD-FORMED.
- WELDING RODS AND BARE ELECTRODES: SELECT ACCORDING TO AWS SPECIFICATIONS FOR METAL ALLOY WELDED.
- GALVANIZING REPAIR PAINT: HIGH-ZINC-DUST-CONTENT PAINT COMPLYING WITH SSPC-PAINT 20.
- FABRICATION, GENERAL: PRE-ASSEMBLE ITEMS IN THE SHOP. CUT DRILL AND PUNCH METALS CLEANLY AND ACCURATELY. REMOVE BURS AND EASE EDGES TO A RADIUS OF 1/32". REMOVE SHARP OR ROUGH AREAS ON EXPOSED SURFACES. WELD CORNERS AND SEAMS CONTINUOUSLY. GALVANIZE ALL METAL FABRICATIONS. PROVIDE ANCHORAGE OF TYPE INDICATED; COORDINATE WITH SUPPORTING STRUCTURE.
- SUPPORTS: FABRICATE UNITS FROM STEEL SHAPES, PLATES AND BARS OF WELDED CONSTRUCTION UNLESS OTHERWISE INDICATED. FABRICATE UNITS TO SIZE AND SHAPE INDICATED AND AS NECESSARY
- TO RECEIVE ADJACENT CONSTRUCTION. 5.7. FINISHES, GENERAL: COMPLY WITH NAAMM'S "METAL FINISHES MANUAL FOR ARCHITECTURAL AND METAL PRODUCTS". FINISH METAL FABRICATIONS AFTER ASSEMBLY. FINISH EXPOSED SURFACES TO REMOVE TOOL AND DIE MARKS AND STRETCH LINES AND BLEND INTO SURROUNDING SURFACE.
- STEEL FINISHES: HOT-DIP GALVANIZE ITEMS TO COMPLY WITH ASTM A 153 FOR STEEL AND IRON HARDWARE AND ASTM A 123 FOR OTHER STEEL AND IRON PRODUCTS.

#### SPECIFICATIONS

1. EXTERIOR ROUGH CARPENTRY

1.1. LUMBER GENERAL: COMPLY WITH DOC PS 20 AND COMPLYING WITH RULES OF AGENCIES CERTIFIED BY ALSC BOARD OF REVIEW. FACTORY MARK EACH ITEM WITH GRADE STAMP OF GRADING AGENCY. PROVIDE DRESSED LUMBER, S4S UNLESS OTHERWISE INDICATED.

1.2. DIMENSION LUMBER

DECK AND STAIR FRAMING, POSTS AND RAILINGS: NO. 1 GRADE

OR BETTER SOUTHERN PINE. RAILING BOARDS: SOUTHERN PINE, B&B FINISH

1.3. LUMBER PRESERVATIVE TREATMENT: PRESSURE TREATED ACCORDING TO AWPA C15 REQUIREMENTS FOR SAWN BUILDING POLES AND POSTS AS STRUCTURAL MEMBERS.

PRESERVATIVE CHEMICALS AS ACCEPTABLE TO AUTHORITIES HAVING JURISDICTION. USE PROCESS THAT INCLUDES WATER REPELLENT TREATMENT.

APPLICATION: TREAT ALL EXTERIOR ROUGH CARPENTRY.

1.4. DECKING: COMPOSITE PLASTIC LUMBER AS SUPPLIED BY THE OWNER. INSTALLED PER MANUFACTURER'S INSTRUCTIONS.

1.5. FASTENERS

STAINLESS STEEL OR HOT DIP GALVANIZED COATING (ASTM A 153 OR ASTM F 2329). USE STAINLESS STEEL FASTENERS WHERE FASTENERS ARE EXPOSED TO VIEW, I.E. HANDRAILS AND DECKING. USE MANUFACTURER RECOMMENDED FASTENER FOR COMPOSITE PLASTIC DECKING. NAILS OR SCREWS SHALL PENETRATE 1-1/2" MINIMUM INTO SUBSTRATE WITHOUT EXITING ON OPPOSITE SIDE.

NAILS: ASTM F 1667

POWER DRIVEN FASTENERS: NES NER-272

WOOD SCREWS: ASME B18.6.1 LAG SCREWS: ASME B18.2.1

CARBON STEEL BOLTS: ASTM A 307 WITH ASTM A 563 HEX NUTS

AND FLAT WASHERS.

POST INSTALLED ANCHORS: STAINLESS STEEL, CHEMICAL OR TORQUE CONTROLLED EXPANSION ANCHORS. STAINLESS STEEL BOLTS AND NUTS COMPLYING WITH ASTM F 593 AND ASTM F 594 ALLOY GROUP 1 OR 2.

- 1.6. METAL FRAMING ANCHORS: SIMPSON STRONG TIE COMPANY, INC. OR OR COMPARABLE PRODUCT
- 1.6.1. PROVIDE PRODUCT WITH ALLOWABLE DESIGN LOADS. AS PUBLISHED BY THE MANUFACTURER, THAT MEET OR EXCEED
- THOSE INDICATED ON THE DRAWINGS GALVANIZED STEEL SHEET: HOT DIP ZINC-COATED SHEET COMPLYING WITH ASTM A 653, G60 OR BETTER COATING
- DESIGNATION. JOIST HANGERS: U-SHAPED WITH 2-INCH LONG SEAT AND 1-1/4-INCH WIDE NAILING FLANGES AT LEAST 85 PERCENT OF
- POST BASES: ADJUSTABLE SOCKET TYPE FOR BOLTING IN PLACE WITH STAND OFF PLATE TO RAISE THE POST 1-INCH MINIMUM ABOVE BASE.

Consultants: **PARSONS** BRINCKERHOFF

Indianapolis, Indiana 46204 t. (317) 972.1706 f. (317) 972.1708

TBIRD Design Services Corp. 105 North 10th Street Lafayette, IN 47901 t. (765) 742.1900 f. 765.742.1905

DATE DESCRIPTION

### pa ark Re path 0

0 1 0 app Ż



Date of Seal Sheet Content

NOTES, LEGEND AND SCHEDULES

DATE November 15, 2012 **AS SHOWN** HLM**DRAWN BY CHECKED BY APPROVED BY** 

Project Number

Sheet Number



- THE PURPOSE OF THIS PLAN IS TO IDENTIFY, IN ADVANCE OF PERMITS, THE TEMPORARY CONSTRUCTION MEASURES THAT WILL BE USED TO PROTECT THE GENERAL PUBLIC IN THE VICINITY OF THE WORK SITE. THE CITY DESIRES TO MINIMIZE THE IMPACT THAT CONSTRUCTION WILL HAVE ON NEIGHBORING PROPERTIES AND THE GENERAL PUBLIC. THE CONTRACTOR SHALL REVIEW AND SUBMIT ANY RECOMMENDED REVISIONS REGARDING THIS PLAN TO THE CITY FOR APPROVAL PRIOR TO ISSUANCE OF A PERMIT FOR CONSTRUCTION.
- THE SITE. ONLY ACCESS THE SITE FROM CITY OWNED FACILITIES AT CONSTRUCTION ENTRANCES INDICATED ON THIS PLAN.
- TREE PROTECTION: DO NOT STORE MATERIALS OR DRIVE EQUIPMENT WITHIN THE DRIP LINE OF EXISTING TREES UNLESS OTHERWISE ZONE BETWEEN THE EDGE OF THE TREE CANOPY AND THE BASE OF THE TREE TRUNK.
- RESULT OF CONSTRUCTION VEHICLES OR ACTIVITIES SHALL BE REPAIRED AT THE CONTRACTOR'S EXPENSE.

#### **KEYED NOTES**

- CONSTRUCTION ENTRANCE: CONTRACTOR SHALL INSTALL A TEMPORARY CONSTRUCTION FENCE AND GATE MEETING THE FOLLOWING **REQUIREMENTS:**
- THE FENCE SHALL BE OF SUFFICIENT LENGTH AND CONFIGURATION
- GATE SHALL HAVE A MINIMUM OF 10' WIDE OPENING. FENCE SHALL BE SECURED WITH POSTS DRIVEN INTO THE GROUND AT 8' ON CENTER MAXIMUM SPACING. USE CAUTION
- 1.6. OPENINGS IN FENCE SHALL BE PROTECTED WITH LOCKABLE GATES
- GATES SHALL BE LOCKED AT ALL TIMES OF CONSTRUCTION WHILE WORKMEN ARE NOT ON THE SITE.
- 2> NORTH SALISBURY STREET ACCESS AREA: A TEMPORARY LANE CLOSURE WILL LIKELY BE REQUIRED FOR DELIVERY OF MATERIALS TO THE SITE FROM NORTH SALISBURY STREET. THE CONTRACTOR SHALL SUBMIT TEMPORARY TRAFFIC CONTROL PLANS TO THE CITY FOR APPROVAL PRIOR TO ISSUANCE OF A BUILDING PERMIT. THE PLAN SHALL INDICATE HOW AND WHEN VEHICULAR AND PEDESTRIAN TRAFFIC WILL BE REDIRECTED AROUND THE ACCESS AREA IN ACCORDANCE WITH
- AROUND THE WORK ZONE IN ACCORDANCE WITH THE INDIANA DEPARTMENT OF TRANSPORTATION WORK ZONE TRAFFIC CONTROL HANDBOOK, LATEST EDITION. APPLICABLE STANDARDS ARE THOSE THAT INCLUDE WORK NEAR AN INTERSECTION.
- LANE CLOSURES SHALL ONLY OCCUR FOR SHORT-TERM DURATIONS FROM 9AM TO 4PM MONDAY THROUGH FRIDAY. REMOVE ALL TEMPORARY TRAFFIC CONTROL DEVICES FROM THE SITE WHILE NOT IN USE.
- 3> CONSTRUCTION SIGN: THE SIGN SHALL BE SECURED TO THE TEMPORARY CONSTRUCTION FENCE BY THE CONTRACTOR ON EACH SIDE OF PROJECT. THE SIGN SHALL DISPLAY THE FOLLOWING VERBIAGE:
- "CONSTRUCTION SITE NO TRESPASSING" THE CONTRACTOR'S NAME AND 24-HOUR EMERGENCY CONTACT
- PHONE NUMBER.
- DUMPSTER: PROVIDE A CONSTRUCTION DUMPSTER WITHIN THE SECURED CONSTRUCTION AREA UNLESS OTHERWISE AUTHORIZED IN WRITING BY
- RECEPTACLES OTHER THAN THE CONSTRUCTION DUMPSTER. (6) CONSTRUCTION STAGING AREA: CONSTRUCTION STAGING MAY OCCUR WITHIN THE AREA IDENTIFIED UNLESS OTHERWISE APPROVED BY THE
- MATERIAL STORAGE: ALL MATERIALS TO BE INCORPORATED INTO THE WORK SHALL BE STORED IN A NEAT AND ORDERLY MANNER WITHIN THE CONFINES OF THE STAGING AREA OR AT THE WORK AREA. MAINTAIN A CLEAR PATH ON THE EXISTING PAVED TRAIL FOR VEHICULAR ACCESS AND ON THE EXISTING DIRT FOOT PATH FOR MATERIAL TRANSPORT TO THE WORK SITE.
- 8 PORTABLE RESTROOM: THE CONTRACTOR SHALL PROVIDE A PORTABLE RESTROOM FOR CONSTRUCTION WORKERS WITHIN THE SECURED CONFINES OF THE WORK ZONE. PROVIDE ROUTINE SERVICE TO THE PORTABLE RESTROOM AS REQUIRED TO KEEP IT IN A SANITARY AND WORKING CONDITION. (9) WORKER PARKING: WORKERS SHALL PARK IN THE EXISTING PARKING
- AUTHORIZED IN WRITING BY THE CITY. WORKERS SHALL NOT PARK ON CITY STREETS OR PRIVATE PROPERTIES. (b) VEHICLES ON EXISTING TRAIL: EXCEPT FOR RESTRICTED WORK ZONES,
- THE EXISTING HAPPY HOLLOW TRAIL WILL BE OPEN TO THE PUBLIC THE EXISTING TRAIL TO ACCESS THE SITE.
- GAS MAIN: USE CAUTION AROUND THE EXISTING GAS MAIN. DO NOT ALLOW SMOKING ON THE PROJECT SITE OR AROUND THE GAS MAIN.

**GENERAL NOTES** 

WORKERS SHALL NOT TRESPASS ON ADJACENT PROPERTIES TO ACCESS

AUTHORIZED BY THE CITY. THE DRIP LINE SHALL BE DEFINED AS THE

ANY DAMAGE TO THE TRAIL, LANDSCAPE OR OTHER FACILITIES AS A

- THE FENCE SHALL BE A MINIMUM 8' HIGH CHAIN LINK. TO CREATE A VISUAL DETERRENT, ±20' EACH SIDE OF GATE.
- AROUND UTILITIES.
- FENCE SHALL BE MAINTAINED IN A PLUMB CONDITION AT ALL
- WITH KEY(S) PLACED IN TO A KNOX BOX.
- THE FOLLOWING:
- 2.1. VEHICULAR AND PEDESTRIAN TRAFFIC SHALL BE REDIRECTED

- PHONE NUMBER THE FENCE CONTRACTOR'S 24-HOUR EMERGENCY CONTACT
- KEY LOCK BOX: CONTRACTOR SHALL SECURE THE KEY LOCK BOX ON OR NEAR THE TEMPORARY CONSTRUCTION FENCE. KEY LOCK BOX STYLE AND MOUNTING LOCATION SHALL BE APPROVED BY THE FIRE
- THE CITY. NO CONSTRUCTION DEBRIS SHALL BE PLACED IN
- LOT AVAILABLE WITHIN HAPPY HOLLOW PARK UNLESS OTHERWISE
- DURING CONSTRUCTION. WATCH OUT FOR PEDESTRIANS WHEN USING

**AS SHOWN** HLM DRAWN BY **CHECKED BY** 

CONSTRUCTION STAGING PLAN

Date of Seal

Sheet Content

APPROVED BY

Sheet Number

PARSONS BRINCKERHOFF

DESCRIPTION

Indianapolis, Indiana 46204 t. (317) 972.1706 f. (317) 972.1708

TBIRD Design Services Corp.

t. (765) 742.1900 f. 765.742.1905

105 North 10th Street

Lafayette, IN 47901


Project Number

**C0.2** 

11-15-12

November 15, 2012



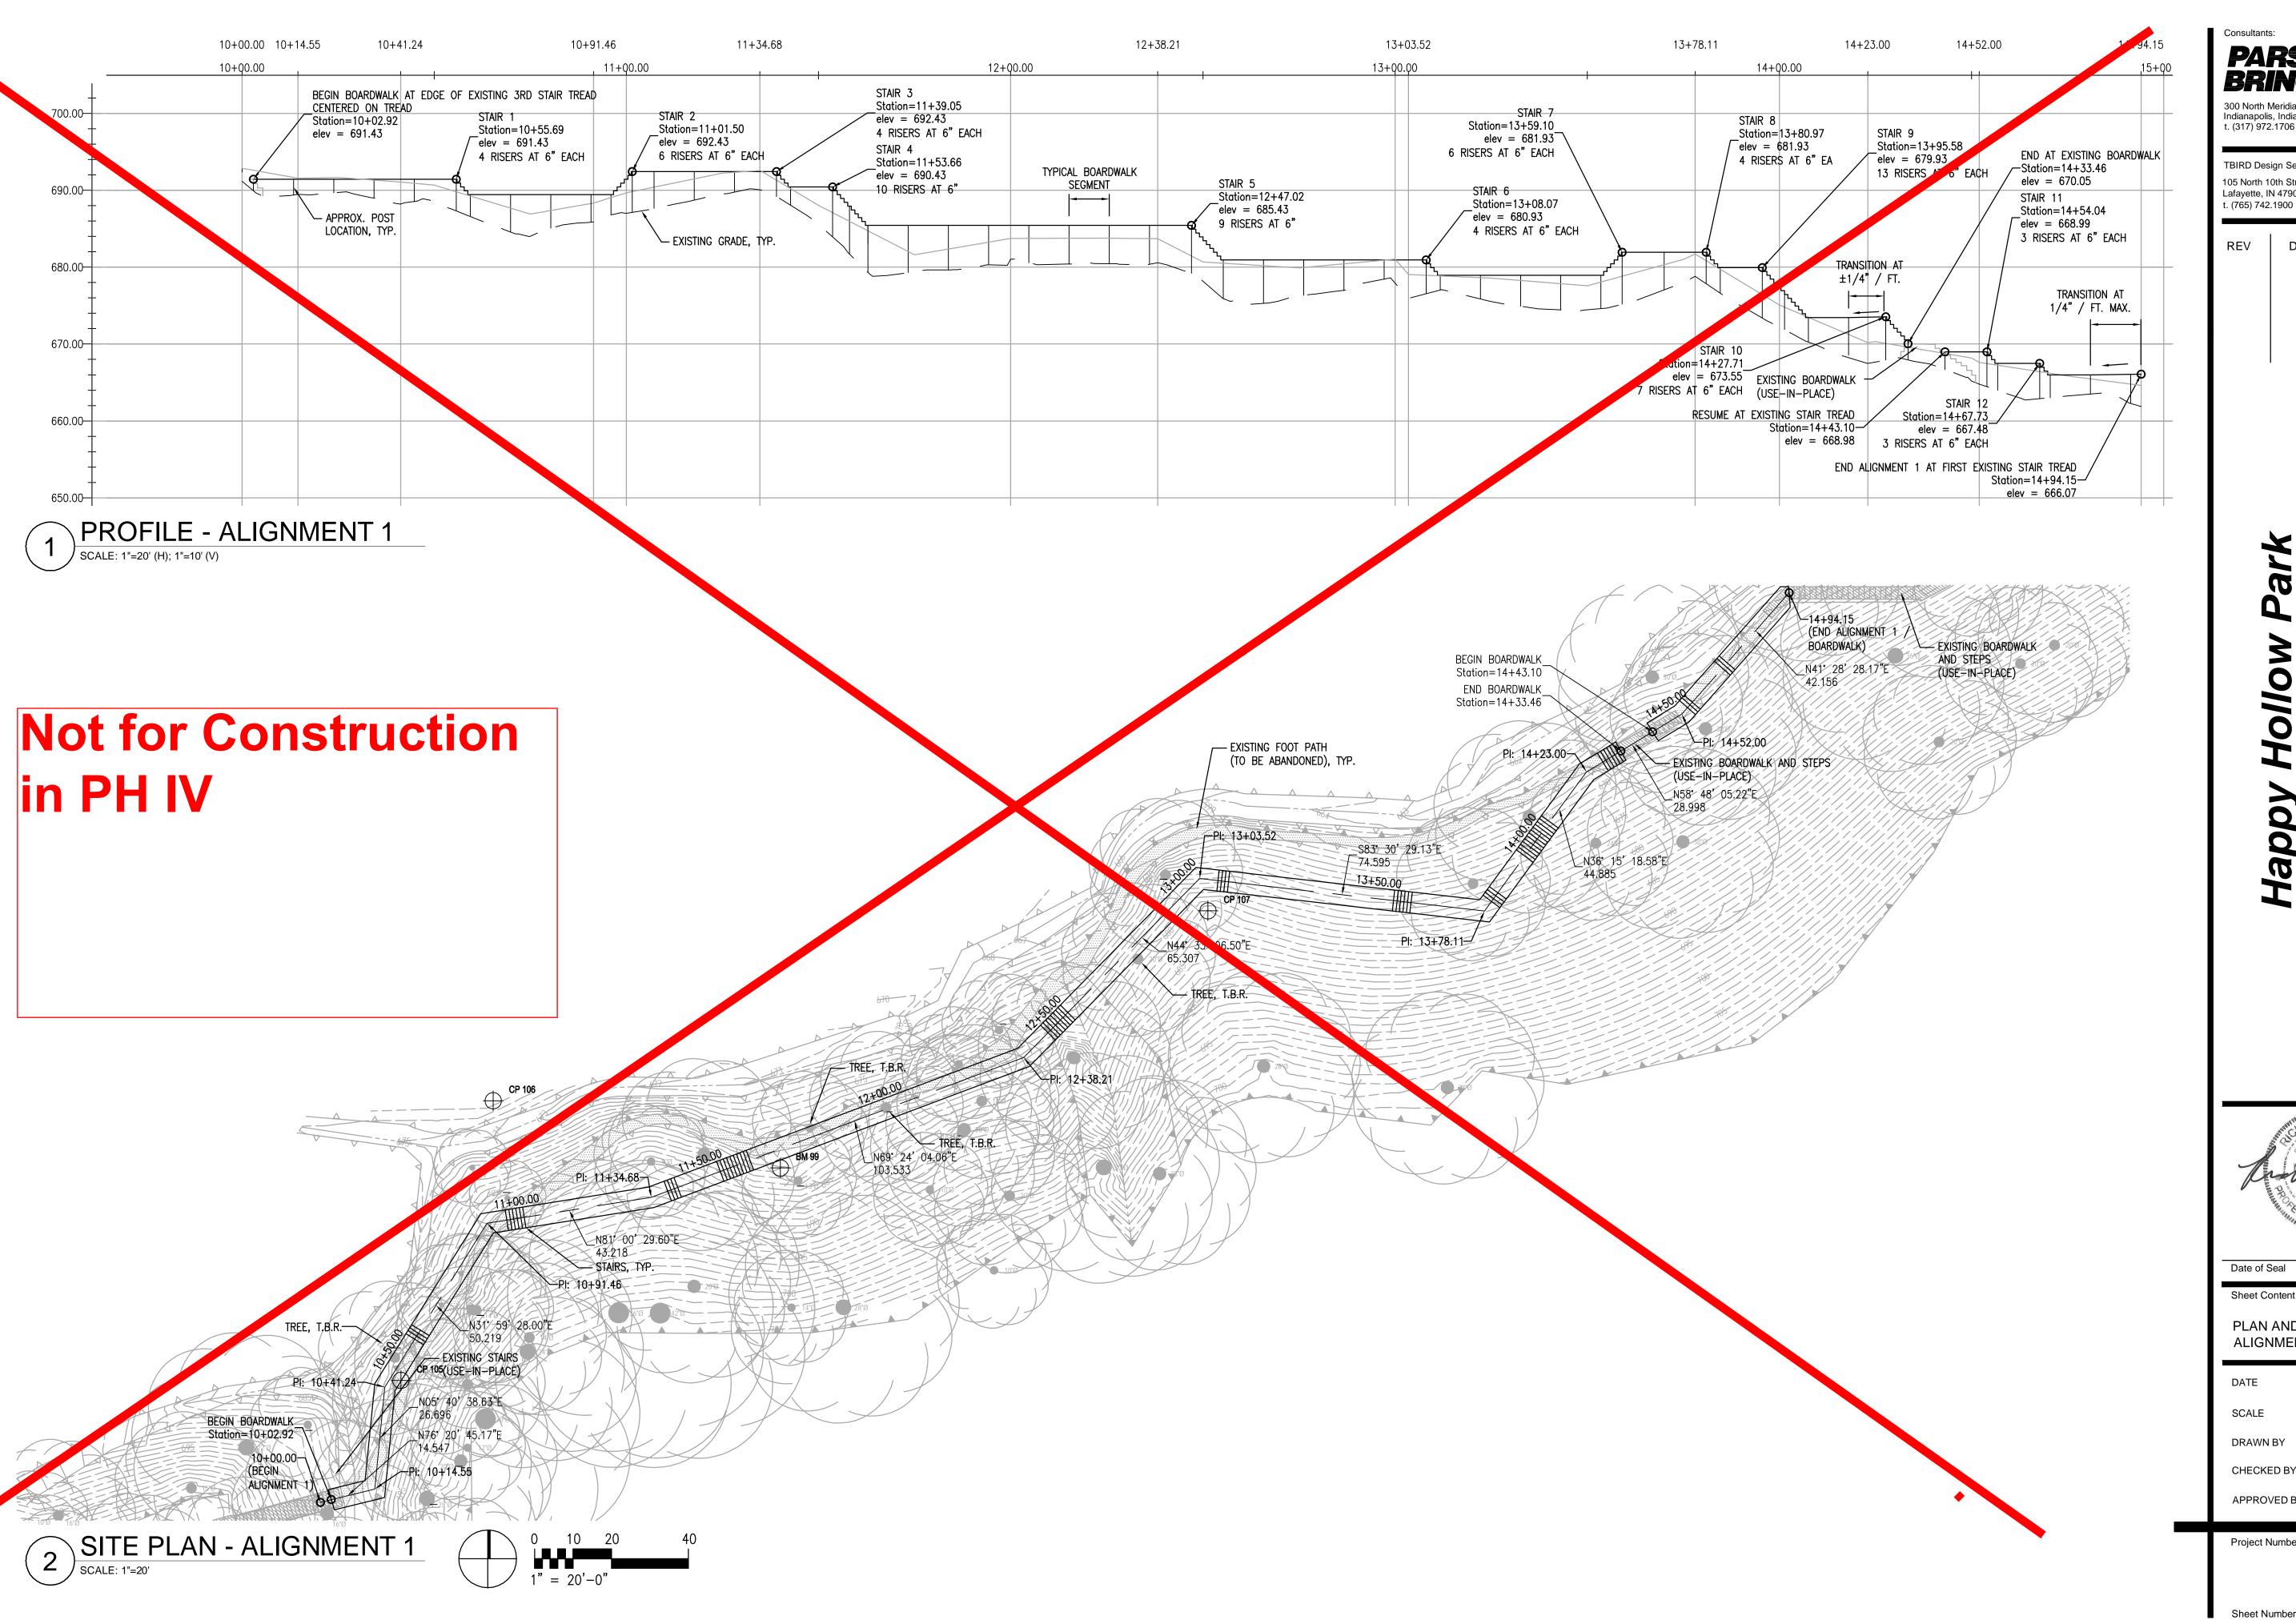


PARSONS BRINCKERHOFF

300 North Meridian Street, Suite 1010 Indianapolis, Indiana 46204 t. (317) 972.1706 f. (317) 972.1708

TBIRD Design Services Corp. 105 North 10th Street Lafayette, IN 47901 t. (765) 742.1900 f. 765.742.1905

DESCRIPTION

## Footpath Hollo Нарру

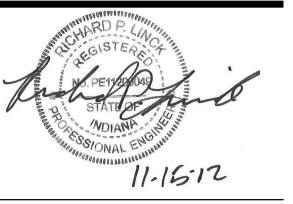


Date of Seal Sheet Content


PLAN AND PROFILE ALIGNMENT 1


DATE	November 15, 2012
SCALE	AS SHOWN
DRAWN BY	HLM
CHECKED BY	WK
APPROVED BY	RL

Project Number

C1.1

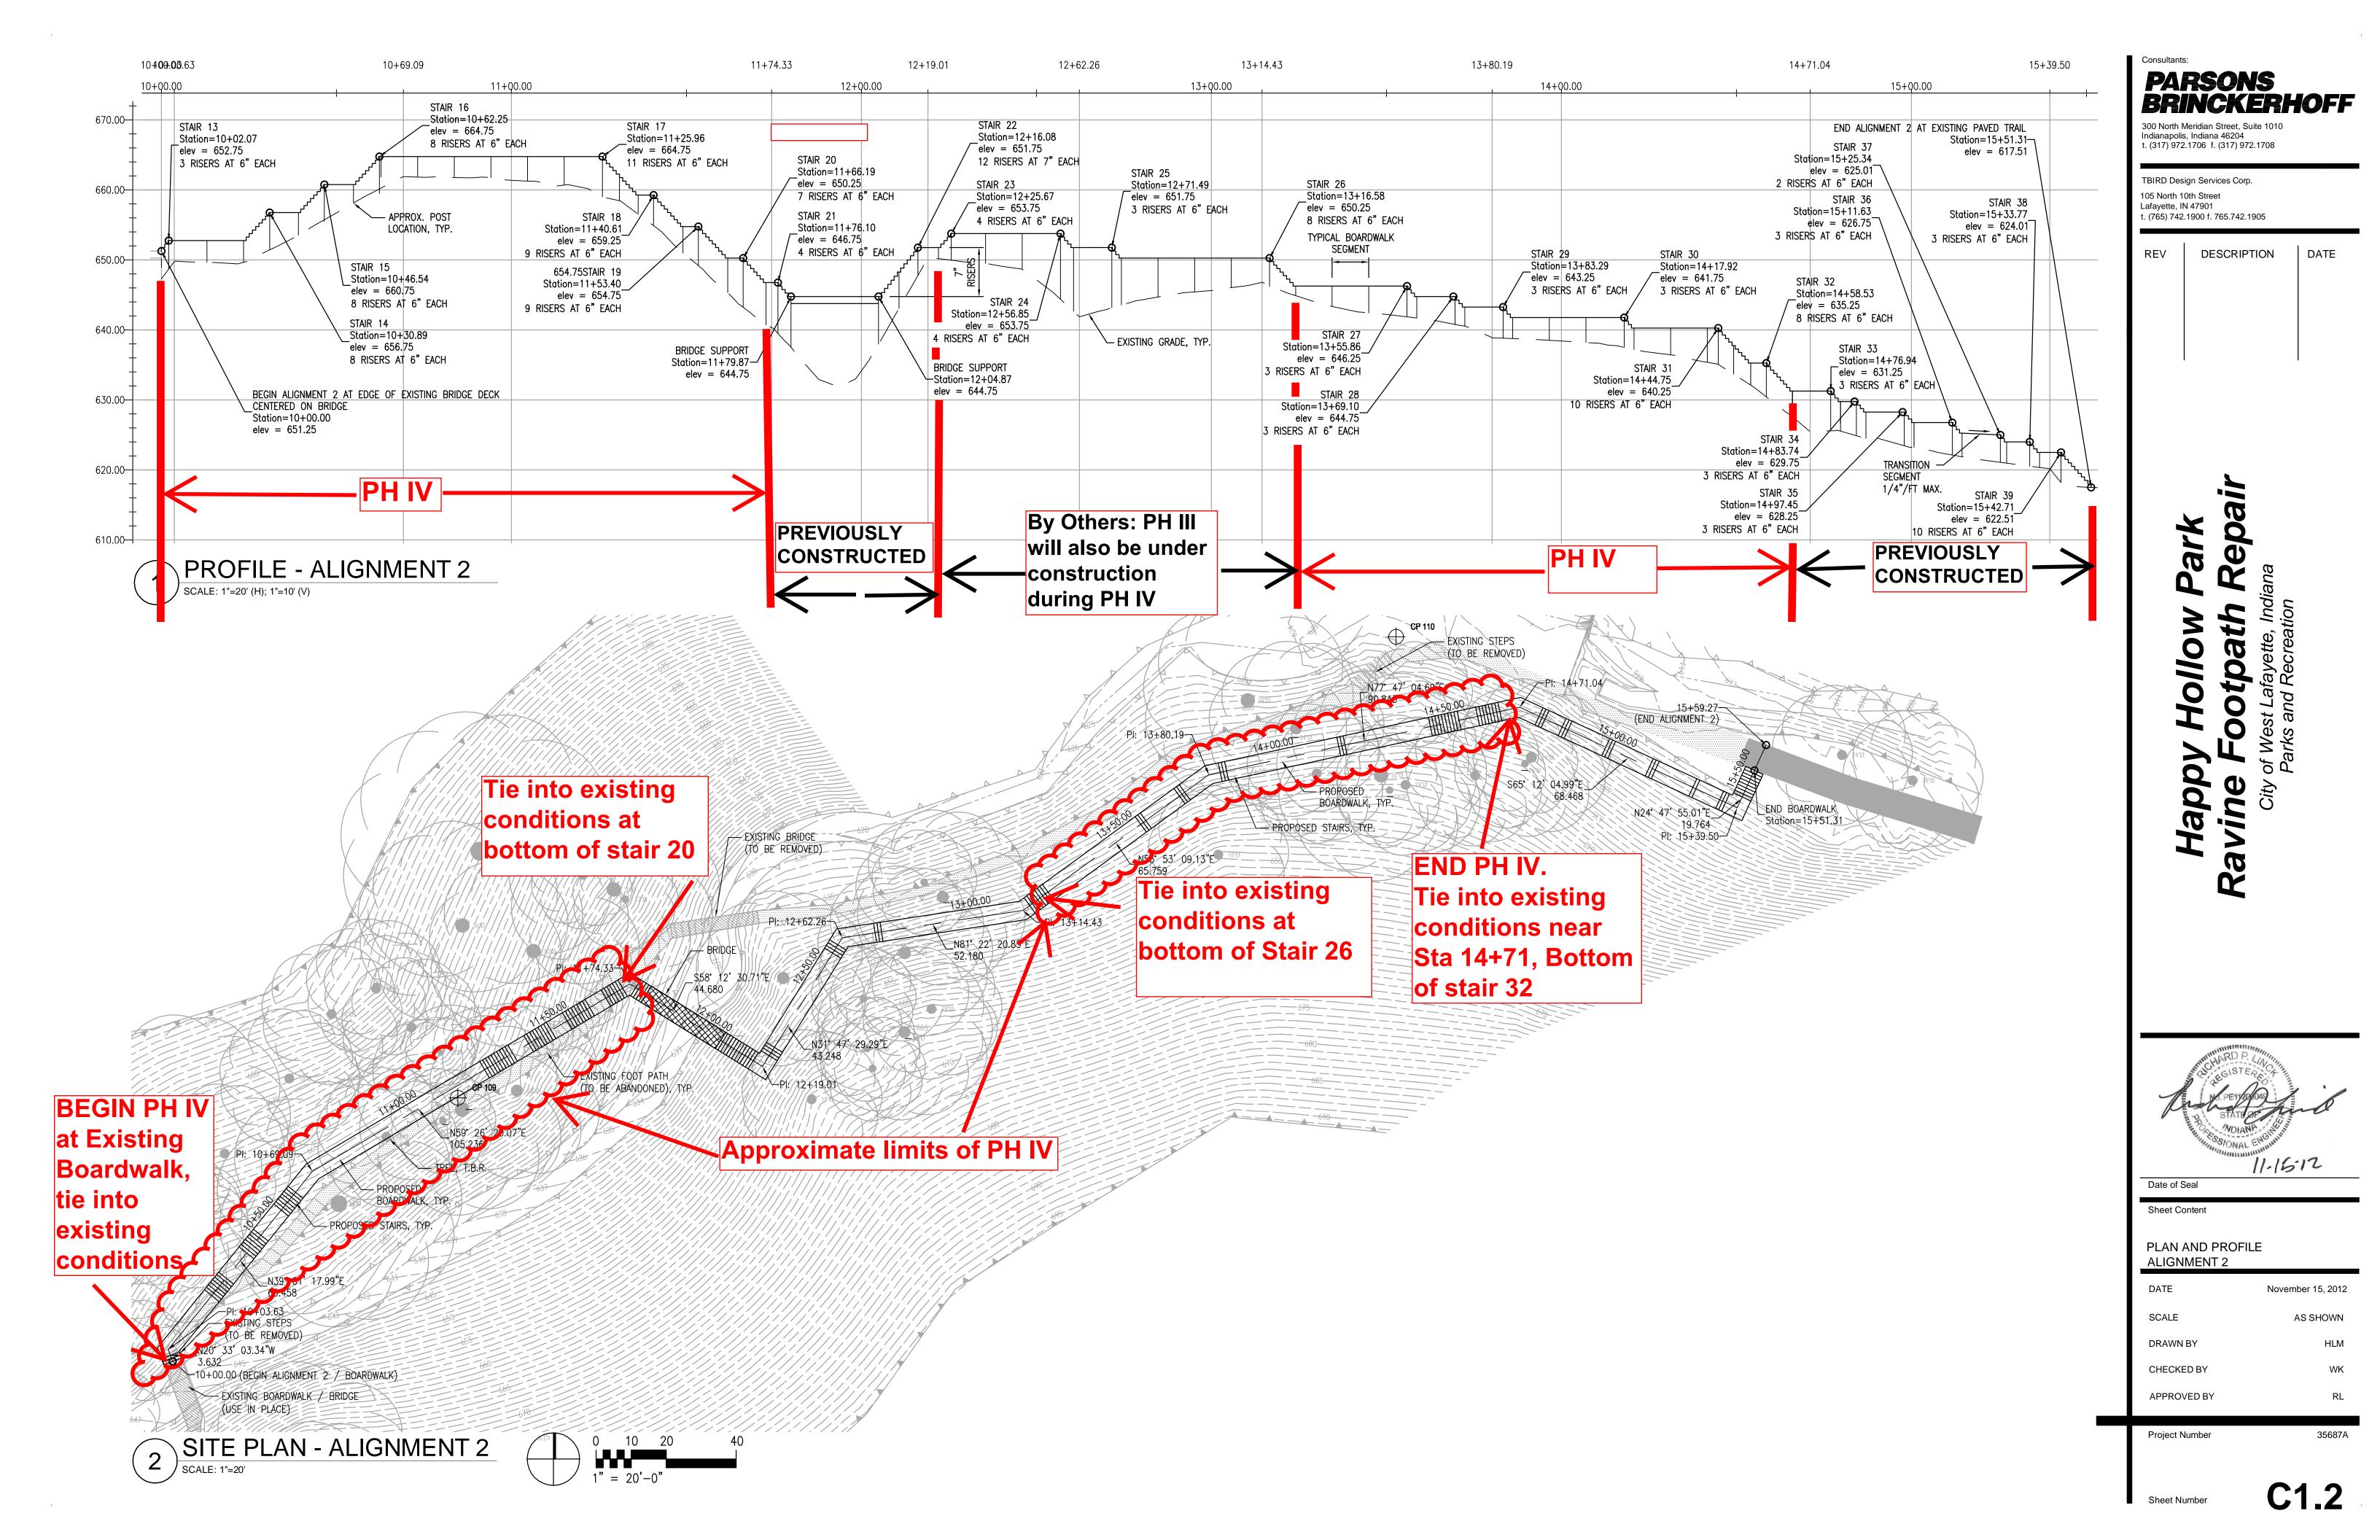

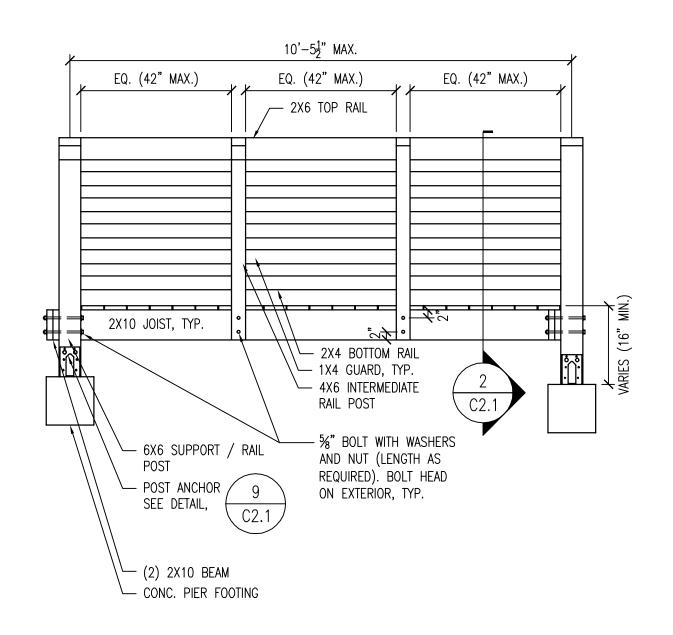


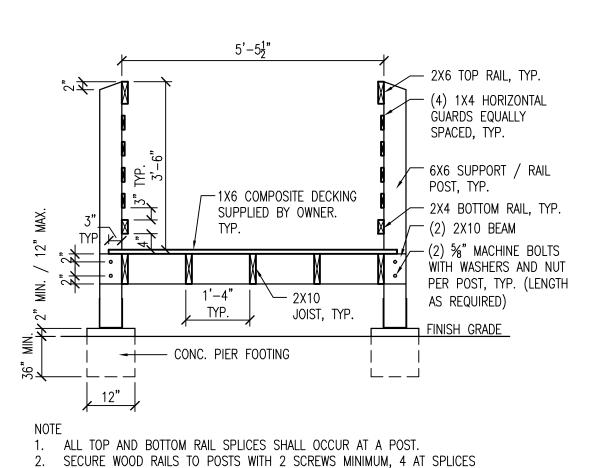

OVER POSTS (2 PER RAIL).

SCALE: 1/2"=1'-0"


BOARDWALK SECTION

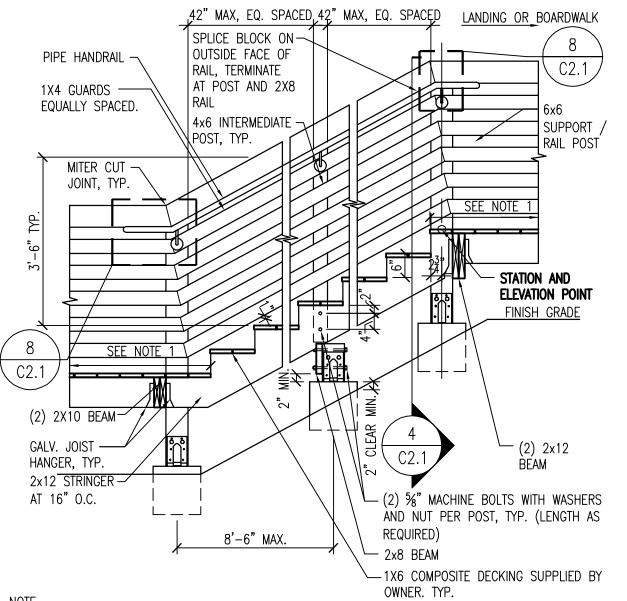


BOARDWALK OR INTERMEDIATE LANDING. INTERMEDIATE LANDINGS SHALL BE AT LEAST AS LONG AS THE STAIR WIDTH (5'-6" MIN.).


2. TERMINATE HANDRAILS AS SHOWN. HANDRAILS SHALL EXTEND ONE TREAD DEPTH BEYOND BOTTOM RISER AND 12" BEYOND TOP RISER, MINIMUM.


#### STAIRWAY SECTION SCALE: 1/2"=1'-0"

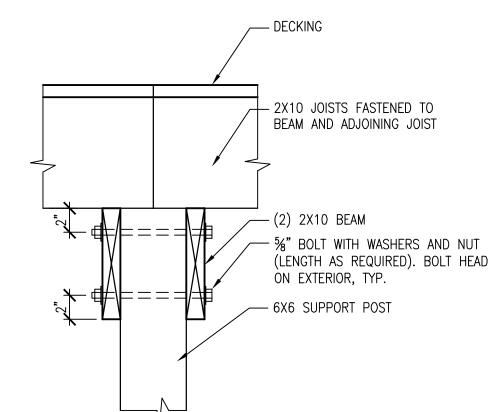




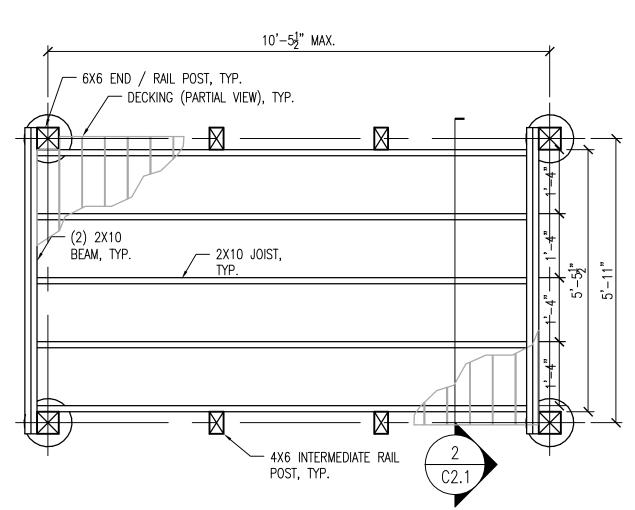

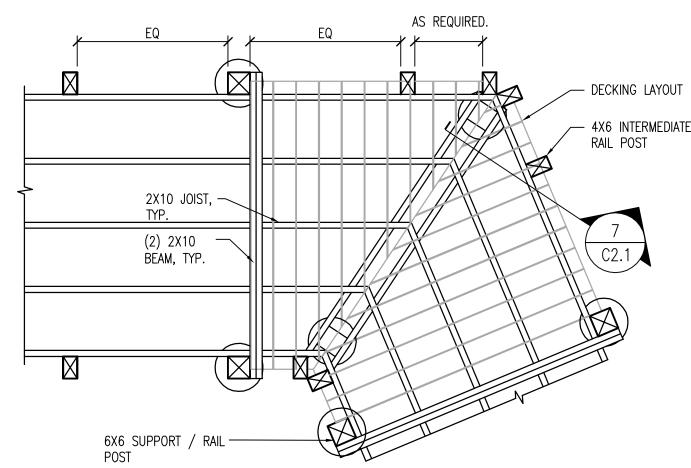

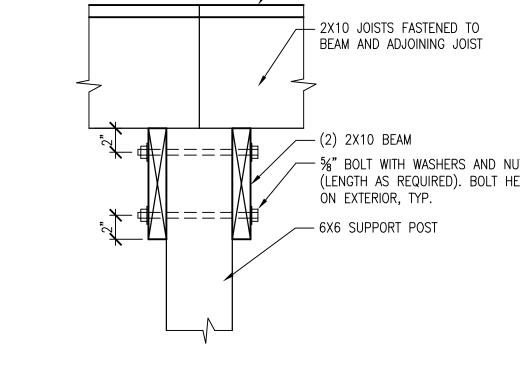

#### BOARDWALK FRAMING PLAN 5 SCALE: 1/2"=1'-0"

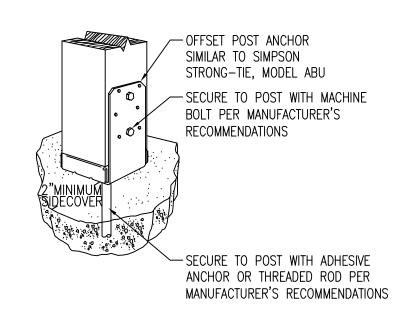

<u>ISOMETRIC</u>


1. INSTALL POST ANCHOR IN ACCORDANCE WITH THE MANUFACTURER'S WRITTEN

2. POST ANCHOR SIZE SHALL MATCH POST SIZE.


TYPICAL POST ANCHOR SCALE: 1/2"=1'-0"





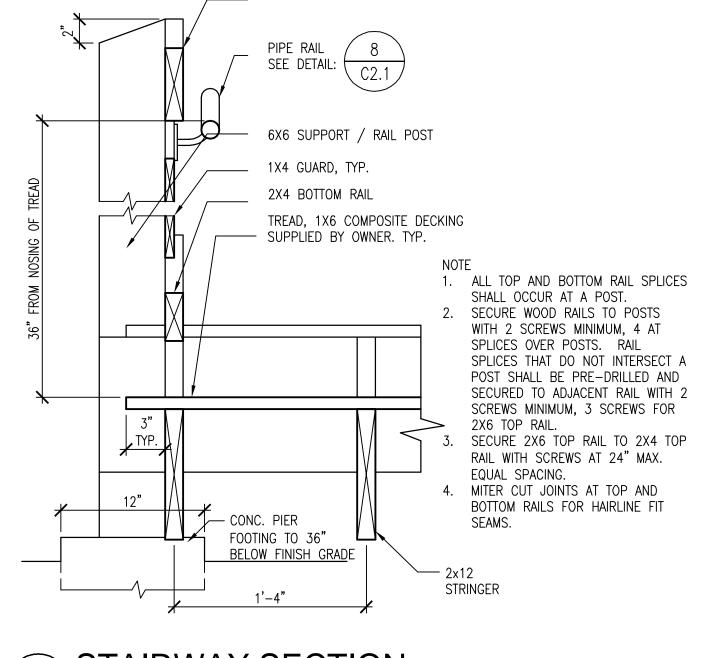

2X6 TOP RAIL

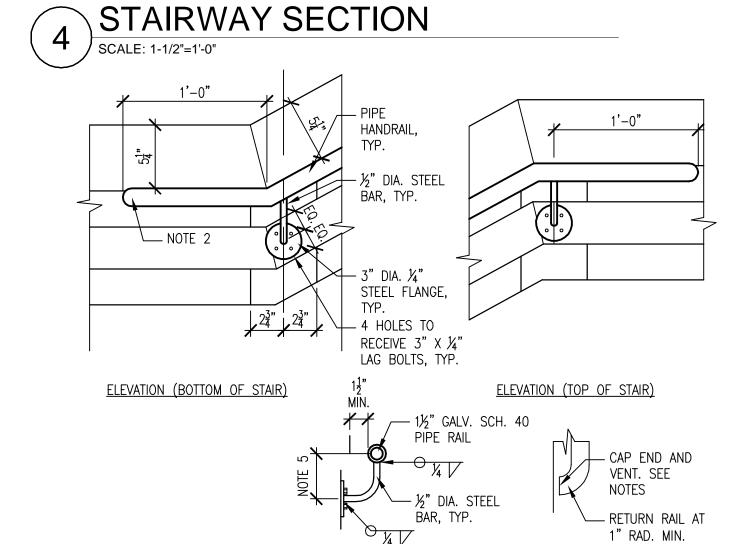

1. TERMINATE HANDRAILS AS SHOWN. HANDRAILS SHALL EXTEND ONE TREAD DEPTH BEYOND BOTTOM RISER AND 12" BEYOND TOP RISER, MINIMUM.

2. TURN ENDS TOWARD WOOD RAIL AND END WITHIN 1/2" OF WOOD RAIL, CAP END. DRILL 1/4" HOLE IN BOTTOM OF RAIL ENDS FOR VENTING.

4. GALVANIZE RAIL ASSEMBLY.

5. BAR LENGTH AS REQUIRED FOR FLANGE AND RAIL POSITIONS INDICATED, 4" MAX.


HANDRAIL AT STAIRS SCALE: 1/2"=1'-0"



TBIRD Design Services Corp. 105 North 10th Street Lafayette, IN 47901 t. (765) 742.1900 f. 765.742.1905

DATE DESCRIPTION

## pa ark Re/ path 0//0 1 0 app İ'n

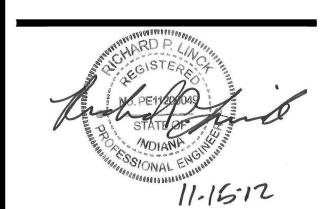

Date of Seal Sheet Content

**BOARDWALK DETAILS** 

DATE	November 15, 2012
SCALE	AS SHOWN
DRAWN BY	HLM
CHECKED BY	WK
APPROVED BY	RL

Project Number

Sheet Number

**C2.1** 

